

Phone: +61 2 8540 8720 ndickson@dicksonrothschild.com.au www.dicksonrothschild.com.au Millers Point, Sydney, NSW 2000 Nominated Architect: Robert Nigel Dickson Registration No: 5364

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REV	DESCRIPTION	DATE	ISSUED	CHECKED
Α	ISSUE FOR DA LODGEMENT	01/10/15	DA	AC
В	AMENDED DA	21/03/16	DA	AC
C	AMENDED RAMP	25/07/2016	RD	AC



22A-34 CLIFF ROAD, EPPING

METRO AWARD

DEVELOPMENT APPLICATION

#### **GENERAL ARRANGEMENT -BASEMENT 1**

14-162 DA-201 SCALE @ A3 DATE 1:500 01/10/2015 CK AC



BASIX REQUIREMENTS

taps and bathroom taps

but <= 7.5 L/min)

approved equivalent)

wet areas

Provision of NO

Energy efficiency;

15,000L Rainwater harvesting tank to collect RW from at least 2,190 m2

Rainwater to serve all toilets and landscape irrigation on ground floor (assumed to be 3,100m2) 4-Star WELS rated toilets, kitchen

3-Star WELS rated showers (> 6

Thermal Comfort:
External walls To achieve a total R

value of 2.3 (Ritek wall systems or

Internal party walls to be of Hebel

Concrete roofs with R3.0 insulation

reflective foil (on both sides of

insulation) below all exposed roofs

floorboards in all dwellings, tiles in

of 4.2 and SHGC of 0.44 (NFRC)

apartments unless thermally sealed

Central gas instantaneous hot

insulation for all external & internal

Gearless traction lift with Variable Voltage & Frequency (VVVF) motor

CO sensors control for carpark

ventilation, with VSD driven fans Provision of mechanical ventilation in lobbies & hallways (exhaust only) Fluorescent lighting with motion

sensor control for carpark lighting

Compact Fluorescent lighting for

all service plants & garbage rooms

Compact Fluorescent lighting with

time clock controls for Foyer and hallways lighting, motion sensors

LED lighting in Lifts, lighting

laundries to be exhausted to the

Single phase air conditioning units

with 2.0 Stars rating for Heating &

apartments unless thermally sealed Gas cooktops and electric ovens

Fluorescent/LED fittings for all

Day-night zoning between

bedrooms and living areas

connected to lift call button Individual bathrooms, kitchens and

with motion sensor control

control for afterhours

Dedicated Compact

Cooling

internal areas

Provision of NO downlights/spotlights in the

water system with R1.0 piping

Windows to achieve a total U-value


type or approved equivalent

Concrete floor slabs with

downlights/spotlights in the

Water efficiency:

of roof area

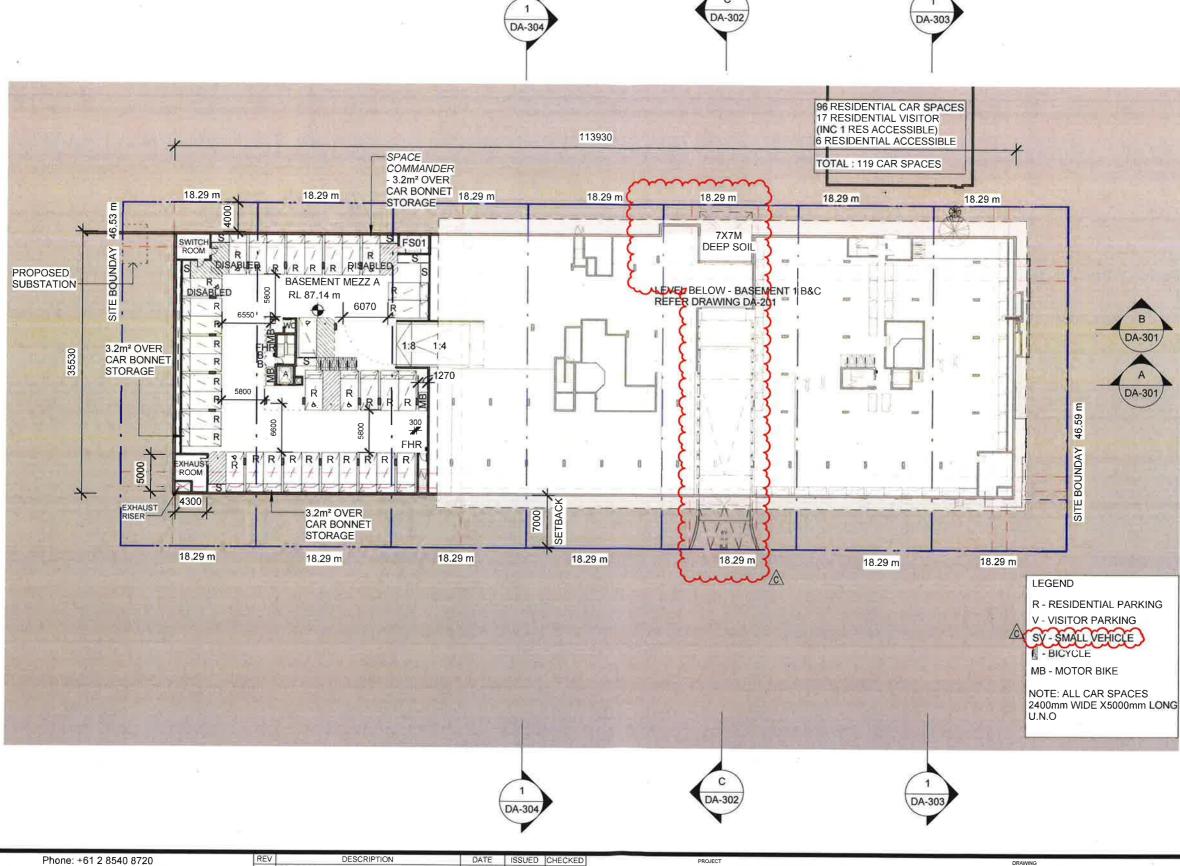

taps and bathroom taps

but <= 7.5 L/min) Thermal Comfort:

approved equivalent)

wet areas

Provision of NO

Energy efficiency;

type or approved equivalent

Concrete floor slabs with

downlights/spotlights in the

of roof area

Water efficiency:

15,000L Rainwater harvesting tank to collect RW from at least 2,190 m2

Rainwater to serve all toilets and landscape irrigation on ground floor (assumed to be 3,100m2)

4-Star WELS rated toilets, kitchen

3-Star WELS rated showers (> 6

 External walls To achieve a total R value of 2.3 (Ritek wall systems or

Internal party walls to be of Hebel

Concrete roofs with R3.0 insulation reflective foil (on both sides of

insulation) below all exposed roofs

floorboards in all dwellings, tiles in

apartments unless thermally sealed

Central gas instantaneous hot

insulation for all external & internal

Gearless traction lift with Variable

Voltage & Frequency (VVVF) motor

Provision of mechanical ventilation in lobbies & hallways (exhaust only)

CO sensors control for carpark

ventilation, with VSD driven fans

Fluorescent lighting with motion sensor control for carpark lighting Compact Fluorescent lighting for all service plants & garbage rooms with motion sensor control

Compact Fluorescent lighting with

Individual bathrooms, kitchens and

Single phase air conditioning units

with 2.0 Stars rating for Heating &

apartments unless thermally sealed

bedrooms and living areas

Gas cooktops and electric ovens Day-night zoning between

laundries to be exhausted to the

time clock controls for Foyer and hallways lighting, motion sensors

control for afterhours LED lighting in Lifts, lighting

Dedicated Compact Fluorescent/LED fittings for all

facade

Cooling

internal areas

Provision of NO downlights/spotlights in the

connected to lift call button

water system with R1.0 piping

Windows to achieve a total U-value of 4.2 and SHGC of 0.44 (NFRC)

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Registration No: 5364

Dickson Rothschild

ABN: 35 134 237 540

9 Argyle Place,

D.R. Design (NSW) Pty. Ltd.

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22A-34 CLIFF ROAD, EPPING

METRO AWARD

DEVELOPMENT APPLICATION

#### GENERAL ARRANGEMENT -BASEMENT MEZZANINE

1:500	01/10/2015	CK	AC
SCALE @ A3	DATE	DRAWN	AUTHORISEE
14-162	DA-202	С	
PHOJECT NO.	DRAWING NO.	REVISION	



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D	AMENDED UNIT AG.04-A3.04	08/09/2016	DA	AC



22A-34 CLIFF ROAD, EPPING


METRO AWARD

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#### **GENERAL ARRANGEMENT -GROUND FLOOR**

PROJECT NO DRAWING NO 14-162 DA-203 D SCALE @ A3 1:500 01/10/2015 SC AC SCALE 1:500



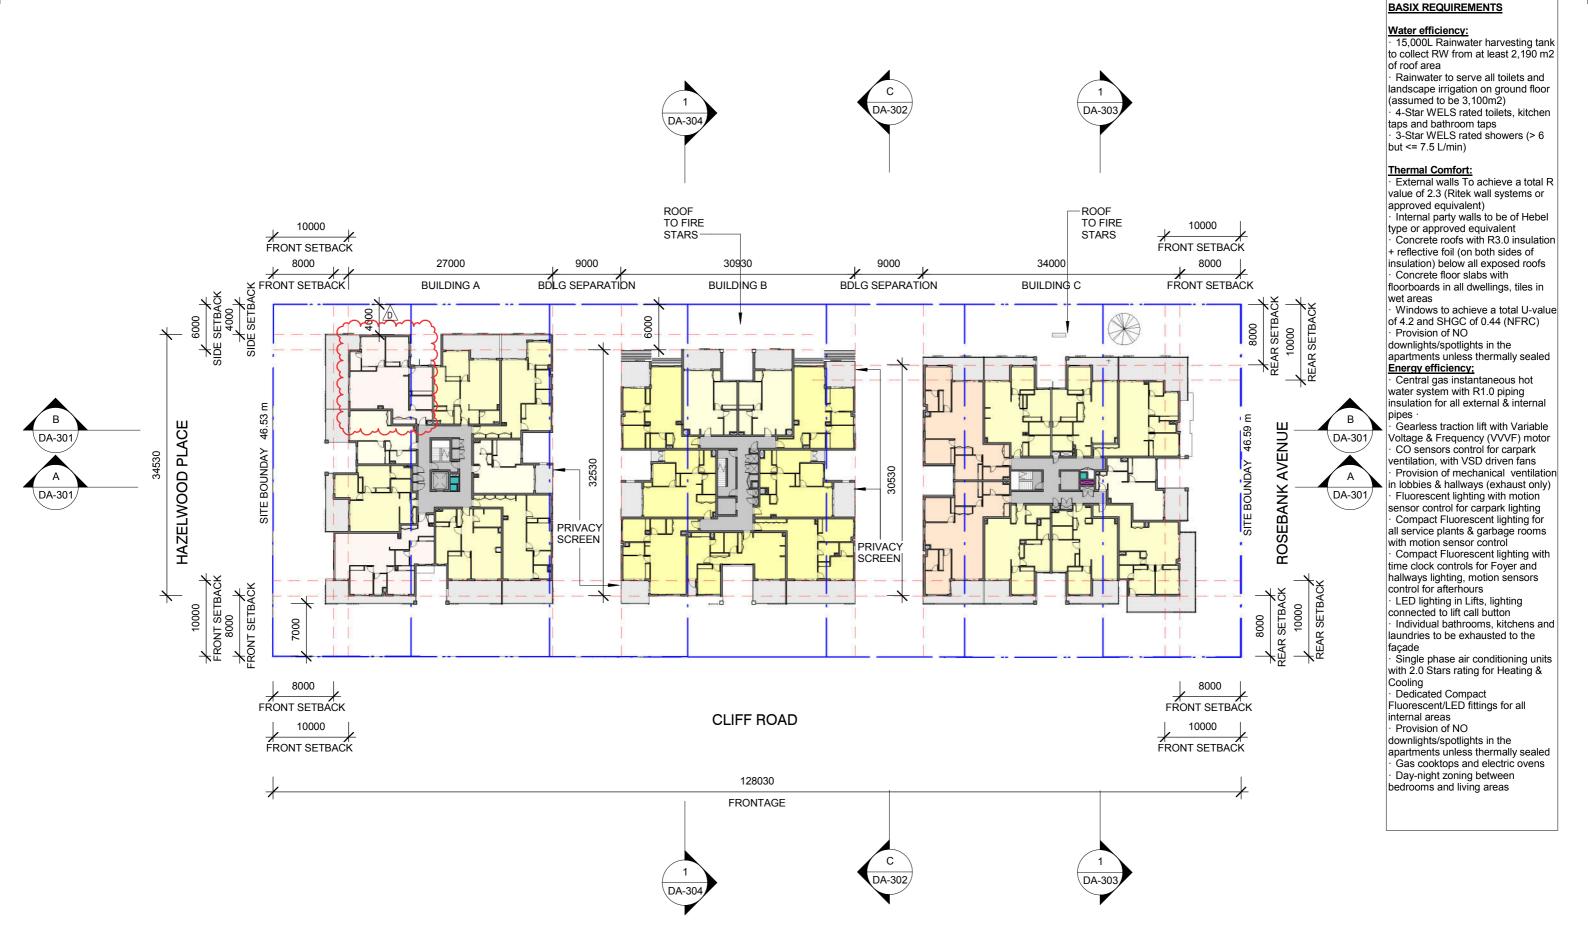

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D	AMENDED UNIT AG.04-A3.04	08/09/2016	DA	AC



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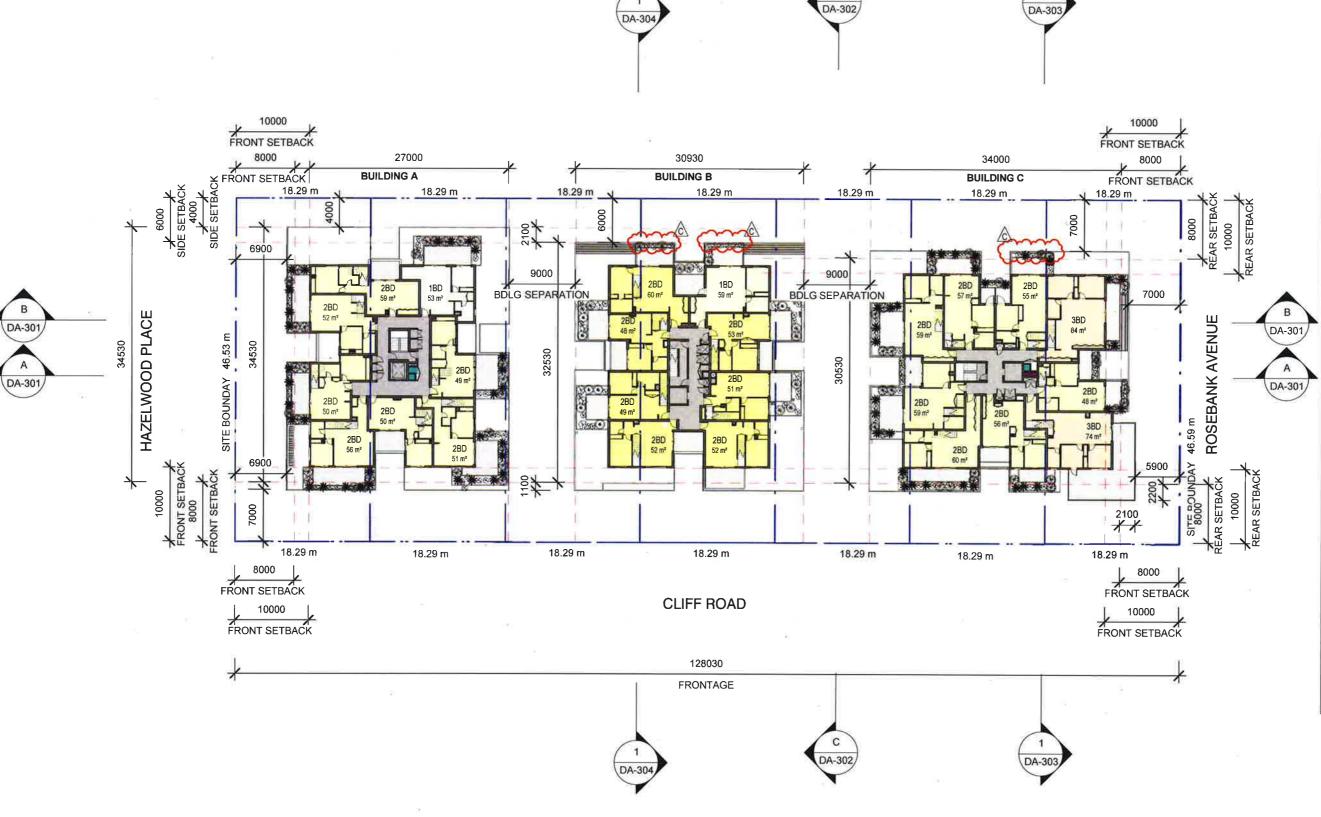
METRO AWARD

DEVELOPMENT APPLICATION

GENERAL ARRANGEMENT -**TYPICAL LEVEL 1-3** 

PROJECT NO DRAWING NO 14-162 DA-204 D SCALE @ A3 1:500 01/10/2015 SC AC SCALE 1:500





Water efficiency:
15,000L Rainwater harvesting tank to collect RW from at least 2,190 m2 of roof area

· Rainwater to serve all toilets and landscape irrigation on ground floor (assumed to be 3,100m2)

4-Star WELS rated toilets, kitchen taps and bathroom taps

3-Star WELS rated showers (> 6 but <= 7.5 L/min)

Thermal Comfort:

· External walls To achieve a total R value of 2.3 (Ritek wall systems or approved equivalent) Internal party walls to be of Hebel

type or approved equivalent Concrete roofs with R3.0 insulation

+ reflective foil (on both sides of insulation) below all exposed roofs Concrete floor slabs with floorboards in all dwellings, tiles in

Windows to achieve a total U-value of 4.2 and SHGC of 0.44 (NFRC)

Provision of NO downlights/spotlights in the apartments unless thermally sealed

Energy efficiency; · Central gas instantaneous hot water system with R1.0 piping

insulation for all external & internal Gearless traction lift with Variable

Voltage & Frequency (VVVF) motor CO sensors control for carpark ventilation, with VSD driven fans Provision of mechanical ventilation in lobbies & hallways (exhaust only)
 Fluorescent lighting with motion

sensor control for carpark lighting Compact Fluorescent lighting for all service plants & garbage rooms with motion sensor control

Compact Fluorescent lighting with time clock controls for Foyer and hallways lighting, motion sensors control for afterhours

LED lighting in Lifts, lighting connected to lift call button Individual bathrooms, kitchens and laundries to be exhausted to the

Single phase air conditioning units with 2.0 Stars rating for Heating & Cooling

Dedicated Compact Fluorescent/LED fittings for all internal areas


Provision of NO downlights/spotlights in the apartments unless thermally sealed

Gas cooktops and electric ovens Day-night zoning between bedrooms and living areas

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**GENERAL ARRANGEMENT -**

LEVEL 4 PROJECT NO. DRA 14-162 DA-205 С SCALE @ A3 1:500 01/10/2015 SC AC SCALE 1:500



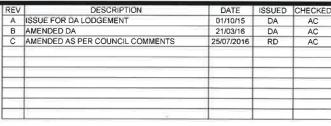

Water efficiency:
- 15,000L Rainwater harvesting tank to collect RW from at least 2,190 m2

Rainwater to serve all toilets and landscape irrigation on ground floor (assumed to be 3,100m2)

4-Star WELS rated toilets, kitchen taps and bathroom taps

3-Star WELS rated showers (> 6 but <= 7.5 L/min)

Thermal Comfort:
External walls To achieve a total R value of 2.3 (Ritek wall systems or

approved equivalent)
Internal party walls to be of Hebel type or approved equivalent Concrete roofs with R3.0 insulation + reflective foil (on both sides of

insulation) below all exposed roofs Concrete floor slabs with floorboards in all dwellings, tiles in wet areas

Windows to achieve a total U-value of 4.2 and SHGC of 0.44 (NFRC) Provision of NO

downlights/spotlights in the apartments unless thermally sealed Energy efficiency;

Central gas instantaneous hot water system with R1.0 piping insulation for all external & internal pipes ·

Gearless traction lift with Variable Voltage & Frequency (VVVF) motor CO sensors control for carpark ventilation, with VSD driven fans Provision of mechanical ventilation in lobbies & hallways (exhaust only)

- Fluorescent lighting with motion sensor control for carpark lighting Compact Fluorescent lighting for all service plants & garbage rooms with motion sensor control Compact Fluorescent lighting with time clock controls for Foyer and hallways lighting, motion sensors control for afterhours

connected to lift call button Individual bathrooms, kitchens and aundries to be exhausted to the Single phase air conditioning units

with 2.0 Stars rating for Heating & **Dedicated Compact** 

Fluorescent/LED fittings for all internal areas Provision of NO downlights/spotlights in the

apartments unless thermally sealed Gas cooktops and electric ovens Day-night zoning between bedrooms and living areas

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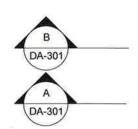
DEVELOPMENT APPLICATION

### GENERAL ARRANGEMENT -**LEVEL 4 MEZZANINE**


PROJECT NO. DRAWING NO 14-162 DA-206 1:500 01/10/2015 SC AC








HAZELWOOD PLACE

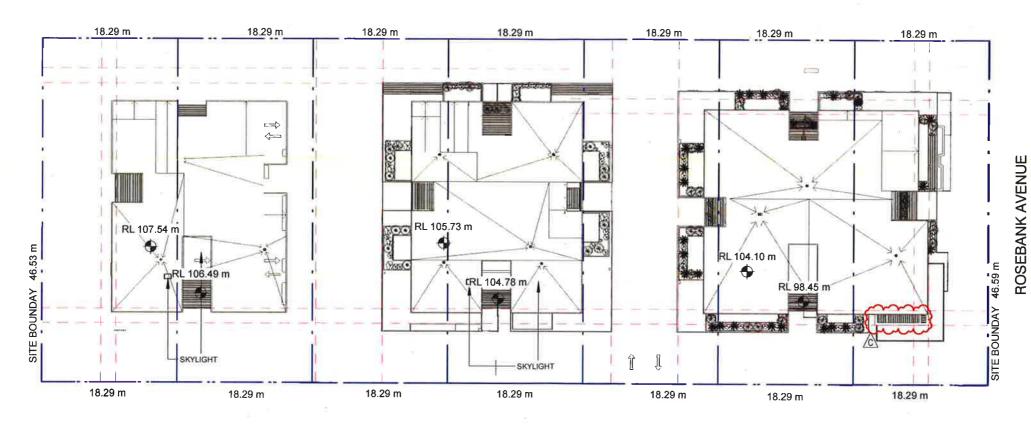

**CLIFF ROAD** 

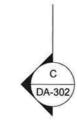

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22A-34 CLIFF ROAD, EPPING

METRO AWARD

DEVELOPMENT APPLICATION

### **GENERAL ARRANGEMENT -**ROOF PLAN

14-162 DA-207 С 1:500 01/10/2015 SC AC SCALE 1:500



BASIX REQUIREMENTS

Water efficiency:
15,000L Rainwater harvesting tank to collect RW from at least 2,190 m2 of roof area

Rainwater to serve all toilets and landscape irrigation on ground floor (assumed to be 3,100m2)

4-Star WELS rated toilets, kitchen taps and bathroom taps · 3-Star WELS rated showers (> 6 but <= 7.5 L/min)

Thermal Comfort:

External walls To achieve a total R value of 2.3 (Ritek wall systems or approved equivalent)

Internal party walls to be of Hebel type or approved equivalent

Concrete roofs with R3.0 insulation + reflective foil (on both sides of

insulation) below all exposed roofs Concrete floor slabs with floorboards in all dwellings, tiles in wet areas

Windows to achieve a total U-value of 4.2 and SHGC of 0.44 (NFRC) Provision of NO downlights/spotlights in the

apartments unless thermally sealed Energy efficiency: Central gas instantaneous hot

water system with R1.0 piping insulation for all external & internal Gearless traction lift with Variable

DA-301/

DA-301

Voltage & Frequency (VVVF) motor CO sensors control for carpark ventilation, with VSD driven fans Provision of mechanical ventilation in lobbies & hallways (exhaust only) · Fluorescent lighting with motion

sensor control for carpark lighting Compact Fluorescent lighting for all service plants & garbage rooms with motion sensor control

Compact Fluorescent lighting with time clock controls for Foyer and hallways lighting, motion sensors control for afterhours LED lighting in Lifts, lighting


connected to lift call button Individual bathrooms, kitchens and laundries to be exhausted to the


· Single phase air conditioning units with 2.0 Stars rating for Heating & Cooling

· Dedicated Compact Fluorescent/LED fittings for all internal areas · Provision of NO

downlights/spotlights in the apartments unless thermally sealed

Gas cooktops and electric ovens Day-night zoning between bedrooms and living areas

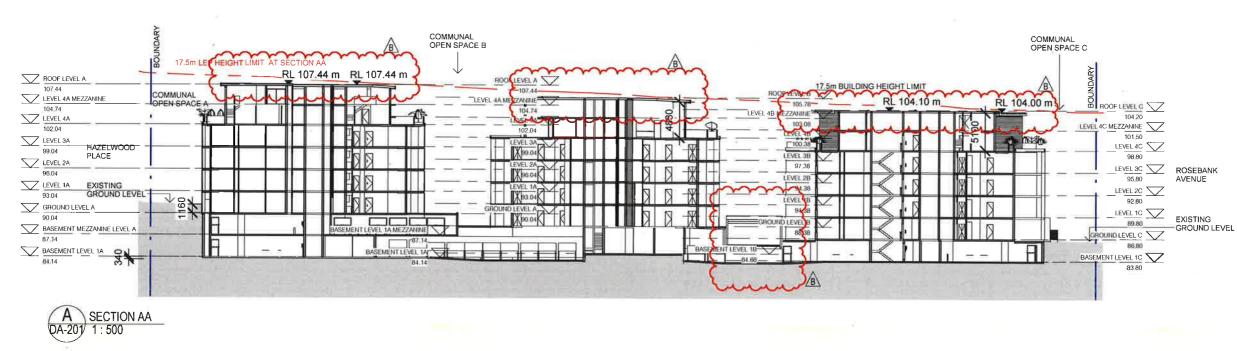

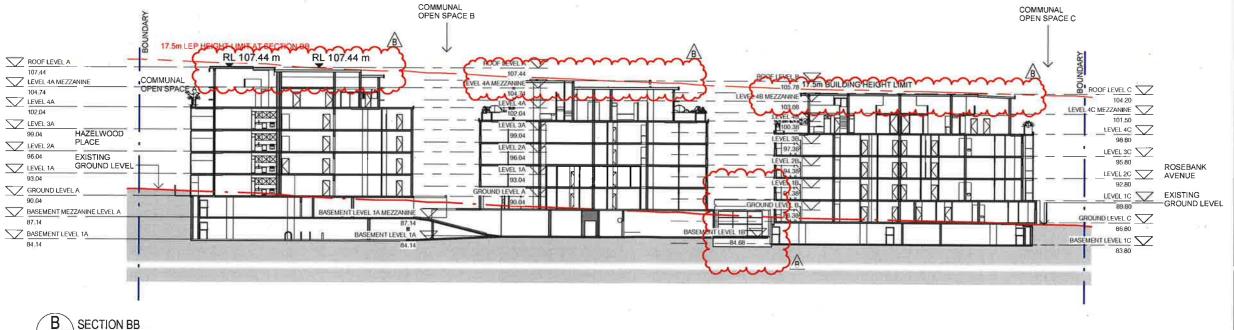

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22A-34 CLIFF ROAD, EPPING

METRO AWARD

DEVELOPMENT APPLICATION

# **SECTION AA & SECTION BB**

PROJECT NO. DRAWING NO. 14-162 DA-301 SCALE @ AX 1:500 01/10/2015 SC AC



Water efficiency:
- 15,000L Rainwater harvesting tank to collect RW from at least 2,190 m2 of roof area Rainwater to serve all toilets and landscape irrigation on ground floor (assumed to be 3,100m2) 4-Star WELS rated toilets, kitchen

taps and bathroom taps
· 3-Star WELS rated showers (> 6 but <= 7.5 L/min)

BASIX REQUIREMENTS

Thermal Comfort:

External walls To achieve a total R value of 2.3 (Ritek wall systems or approved equivalent)

Internal party walls to be of Hebel type or approved equivalent Concrete roofs with R3.0 insulation

reflective foil (on both sides of insulation) below all exposed roofs Concrete floor slabs with

floorboards in all dwellings, tiles in wet areas Windows to achieve a total U-value

of 4.2 and SHGC of 0.44 (NFRC) Provision of NO downlights/spotlights in the apartments unless thermally sealed

Energy efficiency; Central gas instantaneous hot water system with R1.0 piping insulation for all external & internal

Gearless traction lift with Variable Voltage & Frequency (VVVF) motor CO sensors control for carpark ventilation, with VSD driven fans Provision of mechanical ventilation in lobbies & hallways (exhaust only) Fluorescent lighting with motion

sensor control for carpark lighting Compact Fluorescent lighting for all service plants & garbage rooms with motion sensor control


Compact Fluorescent lighting with time clock controls for Foyer and hallways lighting, motion sensors control for afterhours LED lighting in Lifts, lighting

connected to lift call button Individual bathrooms, kitchens and laundries to be exhausted to the facade

Single phase air conditioning units with 2.0 Stars rating for Heating & Cooling · Dedicated Compact Fluorescent/LED fittings for all

internal areas Provision of NO downlights/spotlights in the apartments unless thermally sealed

Gas cooktops and electric ovens Day-night zoning between bedrooms and living areas

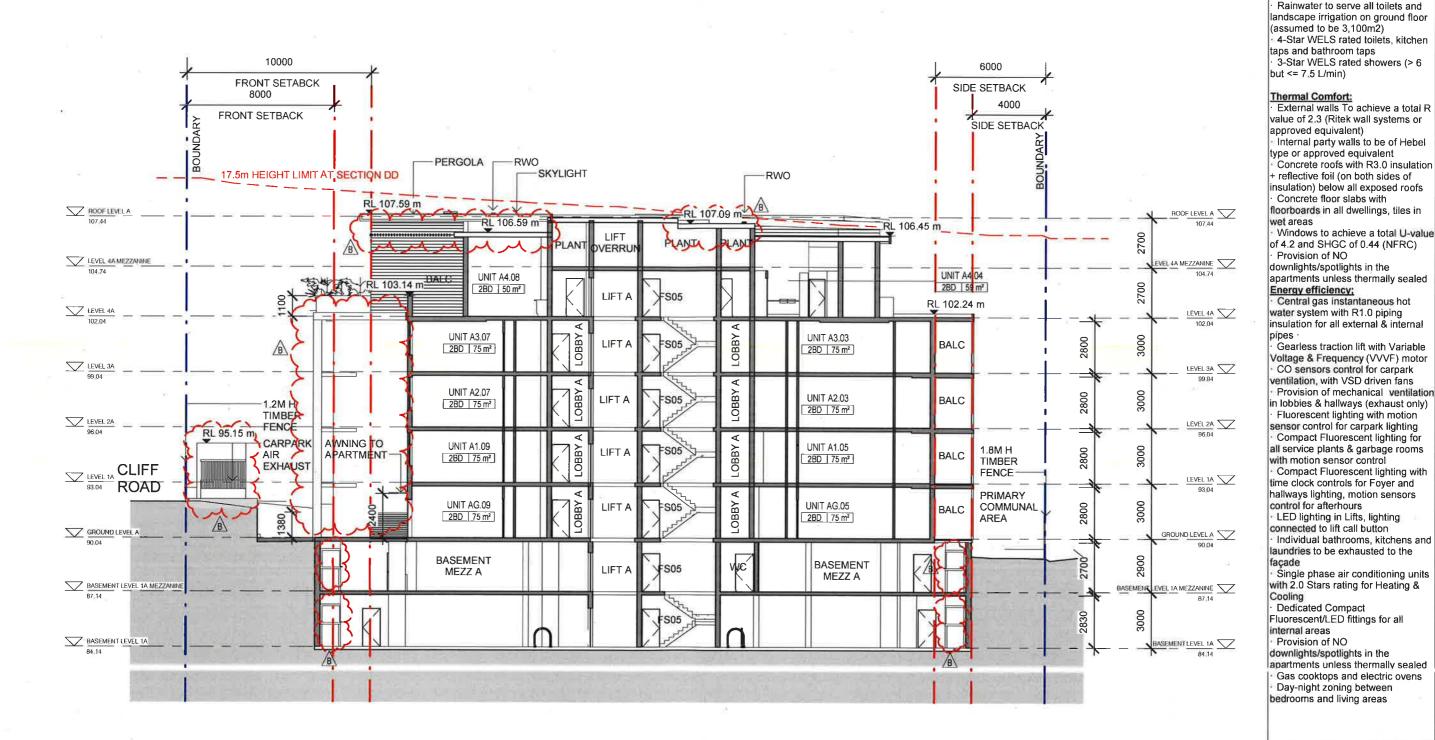

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22A-34 CLIFF ROAD, EPPING

METRO AWARD

DEVELOPMENT APPLICATION

**BUILDING A - SECTION DD** 


14-162 DA-320 SCALE @ A3 1:200 18/08/2015 DC AC SCALE 1:200



BASIX REQUIREMENTS

of roof area

Water efficiency:
- 15,000L Rainwater harvesting tank to collect RW from at least 2,190 m2

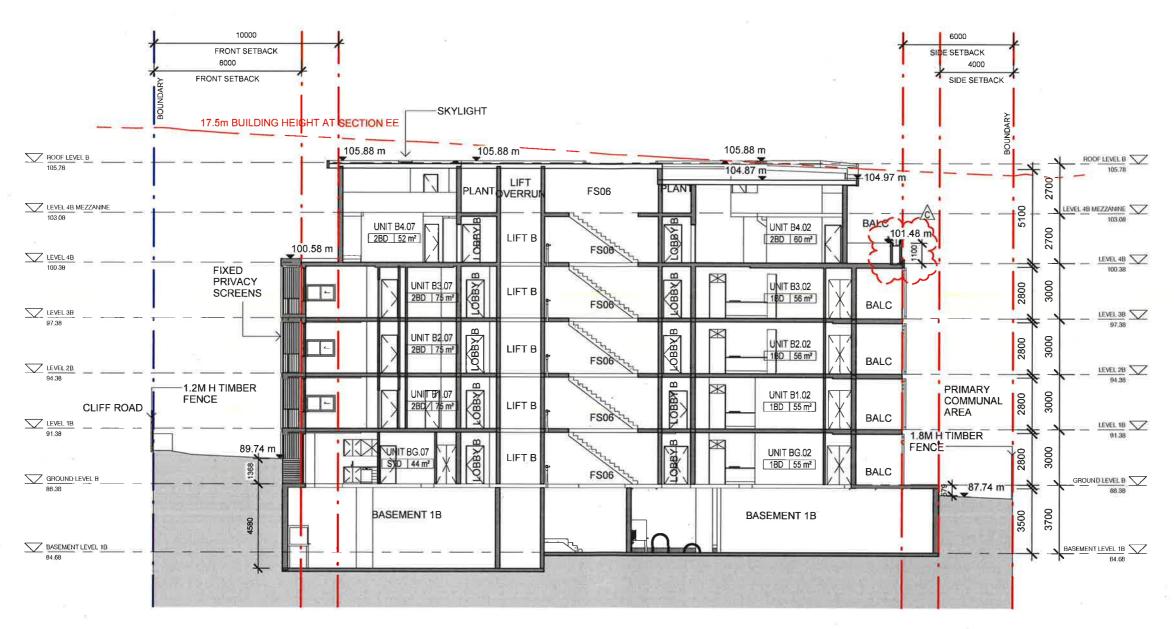

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22A-34 CLIFF ROAD, EPPING

METRO AWARD

DEVELOPMENT APPLICATION

### **BUILDING B - SECTION EE**

14-162 DA-330 C SCALE @ A3 DATE 1:200 18/08/2015 CK AC

BASIX REQUIREMENTS

Water efficiency:
- 15,000L Rainwater harvesting tank to collect RW from at least 2,190 m2 of roof area

· Rainwater to serve all toilets and landscape irrigation on ground floor (assumed to be 3,100m2)

4-Star WELS rated toilets, kitchen taps and bathroom taps · 3-Star WELS rated showers (> 6 but <= 7.5 L/min)

Thermal Comfort:
External walls To achieve a total R value of 2.3 (Ritek wall systems or approved equivalent)

Internal party walls to be of Hebel type or approved equivalent Concrete roofs with R3.0 insulation

+ reflective foil (on both sides of insulation) below all exposed roofs Concrete floor slabs with

floorboards in all dwellings, tiles in

Windows to achieve a total U-value of 4.2 and SHGC of 0.44 (NFRC) Provision of NO

downlights/spotlights in the apartments unless thermally sealed Energy efficiency;
Central gas instantaneous hot

water system with R1.0 piping insulation for all external & internal

Gearless traction lift with Variable Voltage & Frequency (VVVF) motor
CO sensors control for carpark ventilation, with VSD driven fans Provision of mechanical ventilation in lobbies & hallways (exhaust only)

Fluorescent lighting with motion sensor control for carpark lighting Compact Fluorescent lighting for

all service plants & garbage rooms with motion sensor control Compact Fluorescent lighting with time clock controls for Foyer and hallways lighting, motion sensors

control for afterhours LED lighting in Lifts, lighting connected to lift call button


Individual bathrooms, kitchens and laundries to be exhausted to the Single phase air conditioning units

with 2.0 Stars rating for Heating & Cooling Dedicated Compact

Fluorescent/LED fittings for all internal areas Provision of NO

downlights/spotlights in the apartments unless thermally sealed Gas cooktops and electric ovens Day-night zoning between

bedrooms and living areas

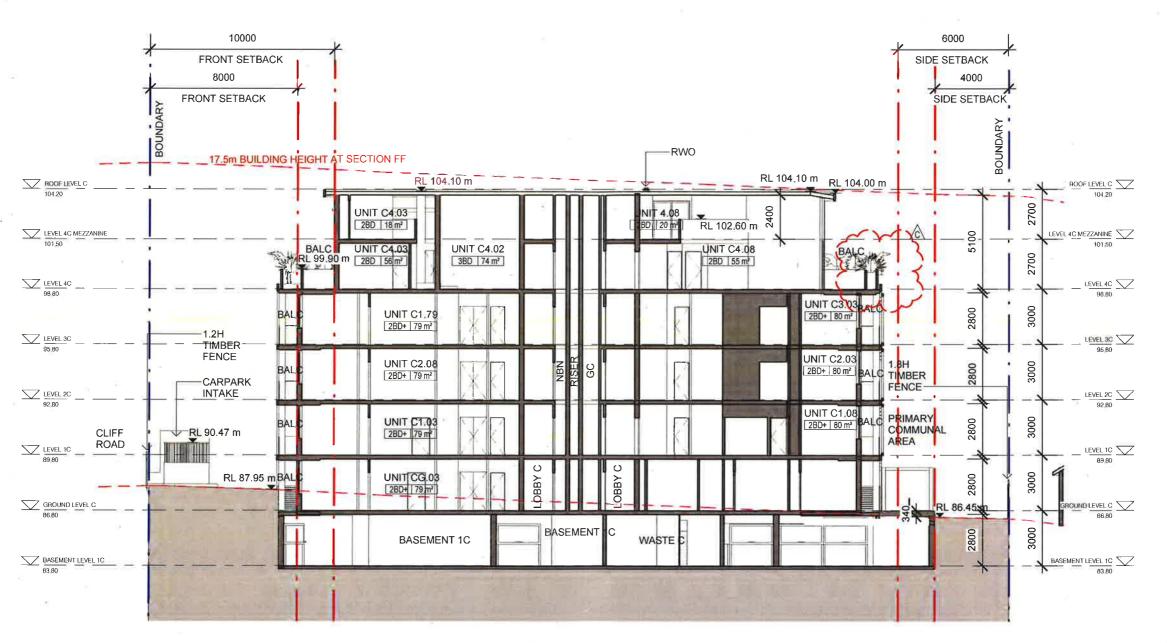

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22A-34 CLIFF ROAD, EPPING

METRO AWARD

DEVELOPMENT APPLICATION

### **BUILDING C - SECTION FF**

14-162 DA-340 С 1:200 18/08/2015 CK AC



Water efficiency:
15,000L Rainwater harvesting tank to collect RW from at least 2,190 m2 of roof area Rainwater to serve all toilets and landscape irrigation on ground floor (assumed to be 3,100m2)

4-Star WELS rated toilets, kitchen

taps and bathroom taps · 3-Star WELS rated showers (> 6 but <= 7.5 L/min)

BASIX REQUIREMENTS

Thermal Comfort:

External walls To achieve a total R value of 2.3 (Ritek wall systems or approved equivalent) · Internal party walls to be of Hebel type or approved equivalent

Concrete roofs with R3.0 insulation + reflective foil (on both sides of insulation) below all exposed roofs

Concrete floor slabs with floorboards in all dwellings, tiles in wet areas · Windows to achieve a total U-value

of 4.2 and SHGC of 0.44 (NFRC) Provision of NO downlights/spotlights in the apartments unless thermally sealed

Energy efficiency; Central gas instantaneous hot water system with R1.0 piping

insulation for all external & internal Gearless traction lift with Variable Voltage & Frequency (VVVF) motor

CO sensors control for carpark ventilation, with VSD driven fans Provision of mechanical ventilation in lobbies & hallways (exhaust only) Fluorescent lighting with motion

sensor control for carpark lighting Compact Fluorescent lighting for all service plants & garbage rooms with motion sensor control


Compact Fluorescent lighting with time clock controls for Foyer and hallways lighting, motion sensors control for afterhours

LED lighting in Lifts, lighting connected to lift call button Individual bathrooms, kitchens and laundries to be exhausted to the

Single phase air conditioning units with 2.0 Stars rating for Heating & Cooling

- Dedicated Compact Fluorescent/LED fittings for all internal areas Provision of NO

downlights/spotlights in the apartments unless thermally sealed Gas cooktops and electric ovens Day-night zoning between bedrooms and living areas

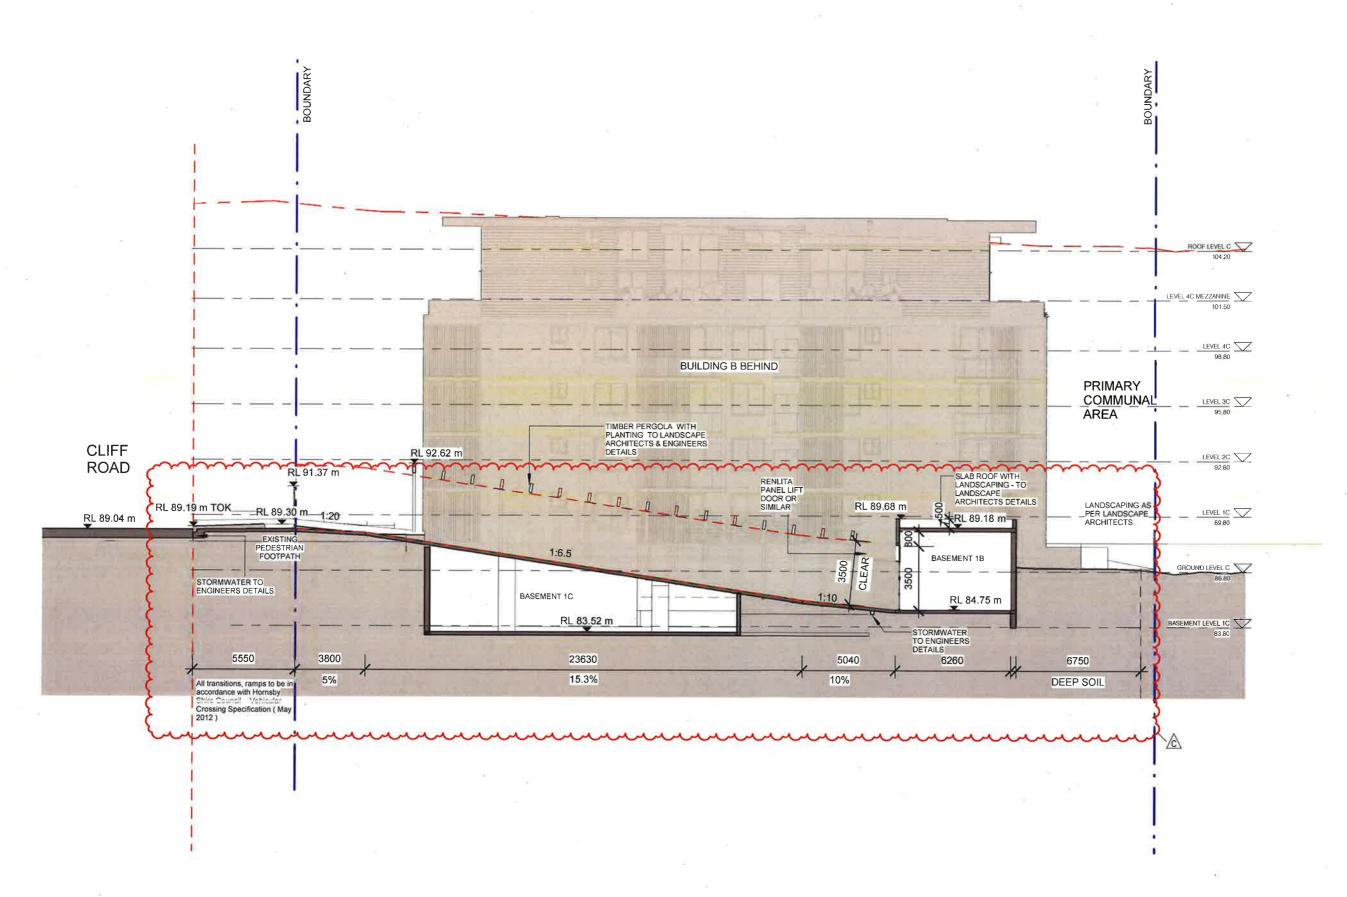

Phone: +61 2 8540 8720 ndickson@dicksonrothschild.com.au www.dicksonrothschild.com.au Millers Point, Sydney, NSW 2000 Nominated Architect: Robert Nigel Dickson Registration No: 5364

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REV	DESCRIPTION	DATE	ISSUED	CHECKED
A	ISSUE FOR DA LODGEMENT	01/10/15	DA	AC
В	AMENDED DA	21/03/16	DA	AC
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22A-34 CLIFF ROAD, EPPING

METRO AWARD

DEVELOPMENT APPLICATION

SECTION CC

PROJECT NO DRAWING NO 14-162 DA-302 SCALE @ A3 1:200 01/10/2015 SC AC

BASIX REQUIREMENTS

Water efficiency:
- 15,000L Rainwater harvesting tank to collect RW from at least 2,190 m2 of roof area

Rainwater to serve all toilets and landscape irrigation on ground floor (assumed to be 3,100m2)

4-Star WELS rated toilets, kitchen taps and bathroom taps
3-Star WELS rated showers (> 6

but <= 7.5 L/min)

Thermal Comfort:
- External walls To achieve a total R value of 2.3 (Ritek wall systems or approved equivalent) Internal party walls to be of Hebel

type or approved equivalent Concrete roofs with R3.0 insulation + reflective foil (on both sides of

insulation) below all exposed roofs Concrete floor slabs with floorboards in all dwellings, tiles in

Windows to achieve a total U-value of 4.2 and SHGC of 0.44 (NFRC) Provision of NO

downlights/spotlights in the apartments unless thermally sealed

Energy efficiency:

Central gas instantaneous hot water system with R1.0 piping insulation for all external & internal pipes · Gearless traction lift with Variable

Voltage & Frequency (VVVF) motor CO sensors control for carpark ventilation, with VSD driven fans Provision of mechanical ventilation in lobbies & hallways (exhaust only)

Fluorescent lighting with motion sensor control for carpark lighting Compact Fluorescent lighting for

all service plants & garbage rooms with motion sensor control Compact Fluorescent lighting with time clock controls for Foyer and hallways lighting, motion sensors

control for afterhours LED lighting in Lifts, lighting connected to lift call button

Individual bathrooms, kitchens and laundries to be exhausted to the façade

Single phase air conditioning units with 2.0 Stars rating for Heating & Cooling Dedicated Compact

Fluorescent/LED fittings for all internal areas · Provision of NO downlights/spotlights in the

apartments unless thermally sealed Gas cooktops and electric ovens Day-night zoning between bedrooms and living areas





SOUTH ELEVATION 1:500

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В	AMENDED DA	21/03/16	DA	AC
С	AMENDED AS PER COUNCIL COMMENTS	25/07/2016	RD	AC
D	AMENDED UNIT AG.04-A3.04	08/09/2016	DA	AC

22A-34 CLIFF ROAD, EPPING

METRO AWARD

DEVELOPMENT APPLICATION

# NORTH & SOUTH **ELEVATION**

PROJECT NO DRAWING NO 14-162 DA-401 D SCALE @ A3 1:500 01/10/2015 FC AC SCALE 1:500



Water efficiency:

15,000L Rainwater harvesting tank to collect RW from at least 2,190 m2 of roof area Rainwater to serve all toilets and landscape irrigation on ground floor (assumed to be 3,100m2) 4-Star WELS rated toilets, kitchen

taps and bathroom taps · 3-Star WELS rated showers (> 6 but <= 7.5 L/min)

**BASIX REQUIREMENTS** 

#### Thermal Comfort:

wet areas

· External walls To achieve a total R value of 2.3 (Ritek wall systems or approved equivalent) Internal party walls to be of Hebel

type or approved equivalent Concrete roofs with R3.0 insulation + reflective foil (on both sides of insulation) below all exposed roofs Concrete floor slabs with floorboards in all dwellings, tiles in

 Windows to achieve a total U-value of 4.2 and SHGC of 0.44 (NFRC) · Provision of NO

downlights/spotlights in the apartments unless thermally sealed Energy efficiency:

· Central gas instantaneous hot water system with R1.0 piping insulation for all external & internal

Gearless traction lift with Variable Voltage & Frequency (VVVF) motor CO sensors control for carpark ventilation, with VSD driven fans Provision of mechanical ventilation in lobbies & hallways (exhaust only) Fluorescent lighting with motion sensor control for carpark lighting · Compact Fluorescent lighting for all service plants & garbage rooms

with motion sensor control · Compact Fluorescent lighting with time clock controls for Foyer and hallways lighting, motion sensors control for afterhours

· LED lighting in Lifts, lighting connected to lift call button Individual bathrooms, kitchens and laundries to be exhausted to the

Single phase air conditioning units with 2.0 Stars rating for Heating & Cooling Dedicated Compact

Fluorescent/LED fittings for all internal areas Provision of NO downlights/spotlights in the

apartments unless thermally sealed Gas cooktops and electric ovens Day-night zoning between bedrooms and living areas



Phone: +61 2 8540 8720 ndickson@dicksonrothschild.com.au www.dicksonrothschild.com.au Millers Point, Sydney, NSW 2000 Nominated Architect: Robert Nigel Dickson Registration No: 5364

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22A-34 CLIFF ROAD, EPPING

METRO AWARD

DEVELOPMENT APPLICATION

# WEST ELEVATION

PROJECT NO DRAWING NO 14-162 DA-402 SCALE @ A3 DATE 1:200 01/10/2015 FC AC



 Internal party walls to be of Hebel type or approved equivalent Concrete roofs with R3.0 insulation + reflective foil (on both sides of insulation) below all exposed roofs Concrete floor slabs with floorboards in all dwellings, tiles in Windows to achieve a total U-value of 4.2 and SHGC of 0.44 (NFRC) Provision of NO downlights/spotlights in the apartments unless thermally sealed Energy efficiency:

Central gas instantaneous hot water system with R1.0 piping insulation for all external & internal Gearless traction lift with Variable Voltage & Frequency (VVVF) motor
- CO sensors control for carpark ventilation, with VSD driven fans Provision of mechanical ventilation in lobbies & hallways (exhaust only) Fluorescent lighting with motion sensor control for carpark lighting Compact Fluorescent lighting for all service plants & garbage rooms with motion sensor control Compact Fluorescent lighting with time clock controls for Foyer and hallways lighting, motion sensors control for afterhours LED lighting in Lifts, lighting connected to lift call button

BASIX REQUIREMENTS

taps and bathroom taps

but <= 7.5 L/min)

approved equivalent)

of roof area

Water efficiency:
15,000L Rainwater harvesting tank to collect RW from at least 2,190 m2

Rainwater to serve all toilets and landscape irrigation on ground floor (assumed to be 3,100m2)

4-Star WELS rated toilets, kitchen

· 3-Star WELS rated showers (> 6

Thermal Comfort:
External walls To achieve a total R value of 2,3 (Ritek wall systems or

with 2.0 Stars rating for Heating & Cooling **Dedicated Compact** Fluorescent/LED fittings for all internal areas

Individual bathrooms, kitchens and laundries to be exhausted to the Single phase air conditioning units

Provision of NO downlights/spotlights in the apartments unless thermally sealed Gas cooktops and electric ovens

Day-night zoning between bedrooms and living areas



Water efficiency:

15,000L Rainwater harvesting tank to collect RW from at least 2,190 m2 of roof area

Rainwater to serve all toilets and landscape irrigation on ground floor (assumed to be 3,100m2)

4-Star WELS rated toilets, kitchen taps and bathroom taps
3-Star WELS rated showers (> 6

but <= 7.5 L/min)

Thermal Comfort:
External walls To achieve a total R value of 2,3 (Ritek wall systems or approved equivalent)

Internal party walls to be of Hebel type or approved equivalent

Concrete roofs with R3.0 insulation reflective foil (on both sides of insulation) below all exposed roofs Concrete floor slabs with

floorboards in all dwellings, tiles in

Windows to achieve a total U-value of 4.2 and SHGC of 0.44 (NFRC) Provision of NO

downlights/spotlights in the apartments unless thermally sealed Energy efficiency;
Central gas instantaneous hot

water system with R1.0 piping insulation for all external & internal Gearless traction lift with Variable

Voltage & Frequency (VVVF) motor

CO sensors control for carpark ventilation, with VSD driven fans Provision of mechanical ventilation in lobbies & hallways (exhaust only)
Fluorescent lighting with motion

sensor control for carpark lighting Compact Fluorescent lighting for all service plants & garbage rooms

with motion sensor control Compact Fluorescent lighting with time clock controls for Foyer and hallways lighting, motion sensors

control for afterhours LED lighting in Lifts, lighting connected to lift call button Individual bathrooms, kitchens and

laundries to be exhausted to the Single phase air conditioning units with 2.0 Stars rating for Heating &

Cooling **Dedicated Compact** Fluorescent/LED fittings for all

internal areas Provision of NO downlights/spotlights in the apartments unless thermally sealed Gas cooktops and electric ovens

Day-night zoning between bedrooms and living areas

Dickson Rothschild D.R. Design (NSW) Pty. Ltd. 9 Argyle Place, ABN: 35 134 237 540

Phone: +61 2 8540 8720 ndickson@dicksonrothschild.com.au www.dicksonrothschild.com.au Millers Point, Sydney, NSW 2000 Nominated Architect: Robert Nigel Dickson Registration No: 5364

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В	AMENDED DA	21/03/16	DA	AC


22A-34 CLIFF ROAD, EPPING METRO AWARD

DEVELOPMENT APPLICATION


**EAST ELEVATION** 14-162 DA-403 SCALE @ A3 DATE 1:200 01/10/2015 FC AC SCALE 1200





REFERENCE	ELEVATION NOTATION	ELEMENT	MATERIAL	FINISH
WALL				
1	P-01	EXTERNAL WALL - FACADE	RENDER WITH PAINT FINISH	DULUX - "SILKWORT" PG2C2 OR SIMILAR
2	P - 02	EXTERNAL WALL - FACADE	JAMES HARDIE "STRIA" CLADDING SYSTEM WITH PAINT FINISH	DULUX - "TIMBER " PG2B5 OR SIMILAR
3	P-03	EXTERNAL WALL - FRAME	RENDER WITH PAINT FINISH	DULUX - "LEXICON QUATER" PN2D1 OR SIMILAR
1	P-04	EXTERNAL WALL - FRAME AND SLAB EDGE	RENDER WITH PAINT FINISH	DULUX - "PLATINUM CLASS " PN2H3 OR SIMILAR
	P - 05	EXTERNAL WALL - FACADE	TERRACOTTA FACADE SYSTEM	TERRACOTTA
	P - 06	EXTERNAL WALL - FACADE	STONE CLADDING SYSTEM	SANDSTONE CLADDING
OWDER COATING	PC - 01	DOORS AND WINDOWS	CLEAR GLASS SET IN POWDER COATED ALUMINUM FRAME	POWDERCOAT - DULUX DURATEC X15 "ZEUS TIMBERLAND" 9007315S OR SIMILAR
POWDER COATING	PC - 01	DOORS AND WINDOWS	CLEAR GLASS SET IN POWDER COATED ALUMINUM FRAME	POWDERCOAT - DULUX DURATEC X15 "ZEUS TIMBERLAND" 9007315S OR SIMILAR
		DOORS AND WINDOWS	CLEAR GLASS SET IN POWDER COATED ALUMINUM FRAME	POWDERCOAT - DULUX DURATEC X15 "ZEUS TIMBERLAND" 9007315S OR SIMILAR
		DOORS AND WINDOWS  BALUSTRADE	CLEAR GLASS SET IN POWDER COATED ALUMINUM FRAME  SEMI-FRAMELESS, CLEAR GLASS SET IN POWDER COATED ALUMINUM FRAME	POWDERCOAT - DULUX DURATEC X15 "ZEUS TIMBERLAND" 9007315S OR SIMILAR  POWDER COATING - DULUX DURATEC X15 "ZEUS LUNAR GREY MATT" 900841 OR SIMILAR
	RIVACY			
	RIVACY BAL - 01	BALUSTRADE	SEMI-FRAMELESS, CLEAR GLASS SET IN POWDER COATED ALUMINUM FRAME	POWDER COATING - DULUX DURATEC X15 "ZEUS LUNAR GREY MATT" 900841 OR SIMILAR
7	RIVACY  BAL - 01  BAL - 02	BALUSTRADE BALUSTRADE	SEMI-FRAMELESS, CLEAR GLASS SET IN POWDER COATED ALUMINUM FRAME SEMI-FRAMELESS, TRANSLUCENT GLASS SET IN POWDER COATED ALUMINUM FRAME	POWDER COATING - DULUX DURATEC X15 "ZEUS LUNAR GREY MATT" 900841 OR SIMILAR POWDER COATING - DULUX DURATEC X15 "ZEUS LUNAR GREY MATT" 900841 OR SIMILAR
POWDER COATING 7  BALUSTRADES AND P. 8 9 10 11	BAL - 01 BAL - 02 L - 01	BALUSTRADE BALUSTRADE FIXED LOUVRES	SEMI-FRAMELESS, CLEAR GLASS SET IN POWDER COATED ALUMINUM FRAME SEMI-FRAMELESS, TRANSLUCENT GLASS SET IN POWDER COATED ALUMINUM FRAME ALUMINIUM	POWDER COATING - DULUX DURATEC X15 "ZEUS LUNAR GREY MATT" 900841 OR SIMILAR POWDER COATING - DULUX DURATEC X15 "ZEUS LUNAR GREY MATT" 900841 OR SIMILAR POWDER COATING - DULUX ELECTRO "SHIMMERING CHAMPAGNE FLAT" 9063116K OR SIMILAR
7 BALUSTRADES AND P 8 9 10	BAL - 01 BAL - 02 L - 01 L - 02	BALUSTRADE BALUSTRADE FIXED LOUVRES SLIDING LOUVRED PANEL	SEMI-FRAMELESS, CLEAR GLASS SET IN POWDER COATED ALUMINUM FRAME SEMI-FRAMELESS, TRANSLUCENT GLASS SET IN POWDER COATED ALUMINUM FRAME ALUMINIUM ALUMINIUM	POWDER COATING - DULUX DURATEC X15 "ZEUS LUNAR GREY MATT" 900841 OR SIMILAR POWDER COATING - DULUX DURATEC X15 "ZEUS LUNAR GREY MATT" 900841 OR SIMILAR POWDER COATING - DULUX ELECTRO "SHIMMERING CHAMPAGNE FLAT" 9063116K OR SIMILAR POWDER COATING - DULUX ELECTRO "SHIMMERING CHAMPAGNE FLAT" 9063116K OR SIMILAR
7 BALUSTRADES AND P 8 9 10	BAL - 01 BAL - 02 L - 01 L - 02	BALUSTRADE BALUSTRADE FIXED LOUVRES SLIDING LOUVRED PANEL	SEMI-FRAMELESS, CLEAR GLASS SET IN POWDER COATED ALUMINUM FRAME SEMI-FRAMELESS, TRANSLUCENT GLASS SET IN POWDER COATED ALUMINUM FRAME ALUMINIUM ALUMINIUM	POWDER COATING - DULUX DURATEC X15 "ZEUS LUNAR GREY MATT" 900841 OR SIMILAR POWDER COATING - DULUX DURATEC X15 "ZEUS LUNAR GREY MATT" 900841 OR SIMILAR POWDER COATING - DULUX ELECTRO "SHIMMERING CHAMPAGNE FLAT" 9063116K OR SIMILAR POWDER COATING - DULUX ELECTRO "SHIMMERING CHAMPAGNE FLAT" 9063116K OR SIMILAR

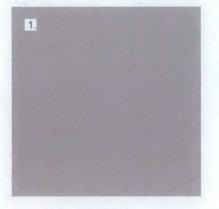



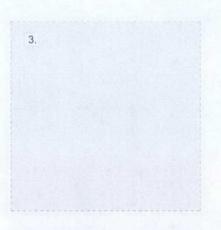

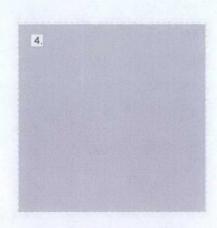

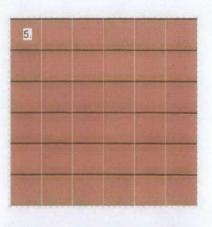














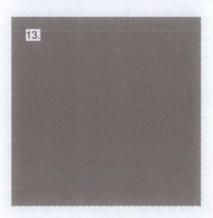

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Nominated Architect: Robert Nigel Dickson
Registration No: 5364

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В	AMENDED DA	21/03/16	DA	AC
C	AMENDED AS PER COUNCIL COMMENTS	25/07/2016	RD	AC

22A-34 CLIFF ROAD, EPPING

METRO AWARD

DEVELOPMENT APPLICATION

14-162 DA-901 SCALE @ AS DATE C 01/10/2015 FC AC

MATERIALS AND FINISH





Dickson Rothschild
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22A-34 CLIFF ROAD, EPPING

METRO AWARD

DEVELOPMENT APPLICATION

VISUALISATION 1

14-162 DA-003 SCALE @ A3 DATE 01/10/2015 CP AC





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22A-34 CLIFF ROAD, EPPING


METRO AWARD

DEVELOPMENT APPLICATION

VISUALISATION 2

PROJECT NO DRAWING NO 14-162 DA-004 SCALE @ A3 DATE 01/10/2015 CP



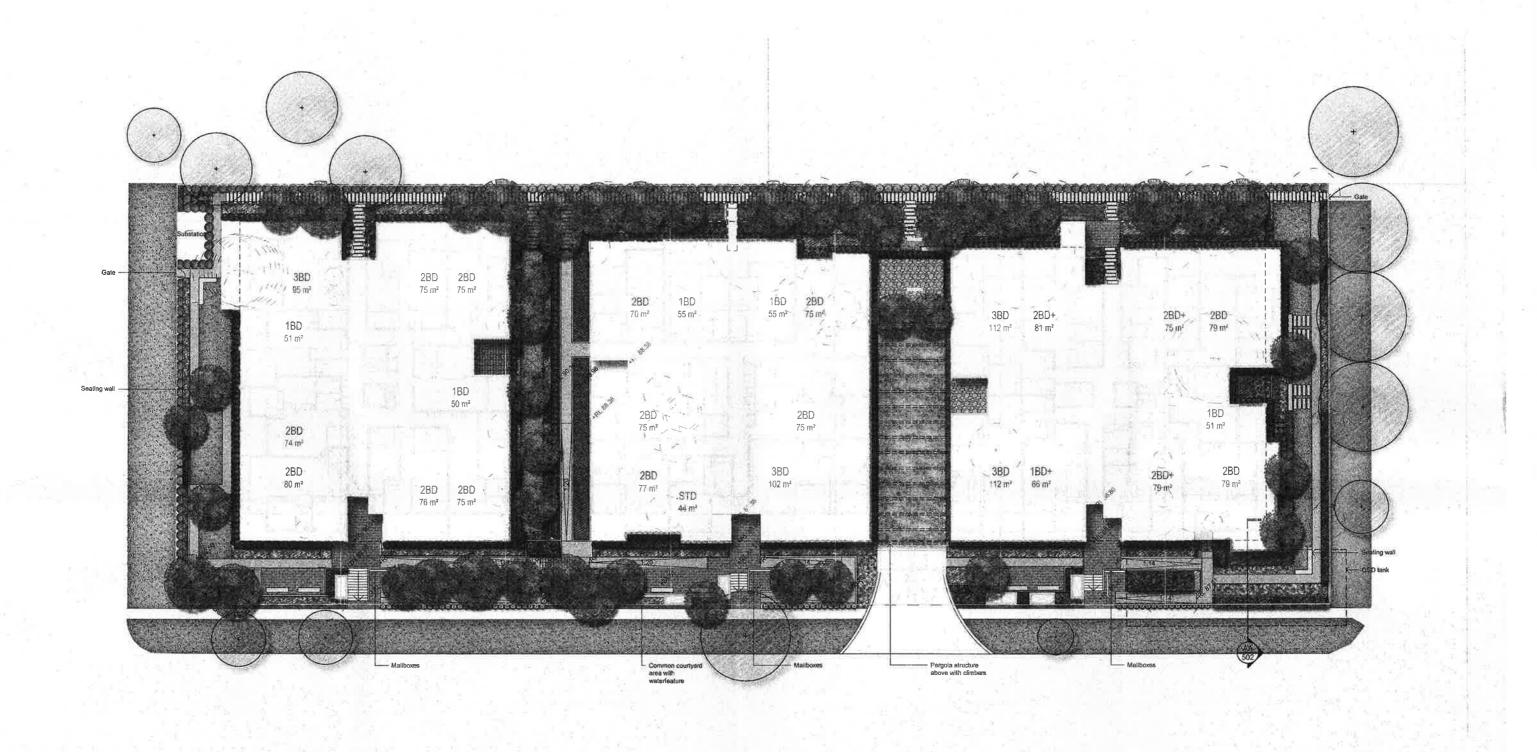

# NOT FOR CONSTRUCTION

JW NM 27.04.16
JW NM 17.03.16
JW NM 17.03.16
JD NM 08.12.16
JD NM 08.12.16
JD NM 29.06.18
JM NM 29.06.16
JM NM 23.09.15
JM NM 23.09.15
JM NM 23.09.15
JM NM 20.09.16

LEGEND

Fence

Shrubs Grasses & Groundcovers

Stepping Pavers Steel Edge



22a-32 Cliff Road, Epping

Colour Landscape Plan

**PRELIMINARY** 

Scale: 1:200 @ A1 SS15-3045

C101 J